

গুরুত্বপূর্ণ বিবরণ

এই নকশাটি একটি নির্দিষ্ট উদ্দেশ্যে তৈরি করা হয়েছে এবং এটি কেবলমাত্র নির্মাণের জন্য ব্যবহার করা উচিত। এটি কোনও অন্যান্য উদ্দেশ্যে ব্যবহার করা হবে না।




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এই নকশাটি একটি নির্দিষ্ট উদ্দেশ্যে তৈরি করা হয়েছে এবং এটি কেবলমাত্র নির্মাণের জন্য ব্যবহার করা উচিত। এটি কোনও অন্যান্য উদ্দেশ্যে ব্যবহার করা হবে না।

এই নকশাটি একটি নির্দিষ্ট উদ্দেশ্যে তৈরি করা হয়েছে এবং এটি কেবলমাত্র নির্মাণের জন্য ব্যবহার করা উচিত। এটি কোনও অন্যান্য উদ্দেশ্যে ব্যবহার করা হবে না।

ক্রমিক নং	বিবরণ	মাত্রা
১	কম্পিউটার	১৫০০x১৫০০
২	ফটোকপি	১৫০০x১৫০০
৩	প্রিন্টার	১৫০০x১৫০০
৪	স্ক্যানার	১৫০০x১৫০০
৫	ফ্যাক্স	১৫০০x১৫০০
৬	ইন্টারনেট	১৫০০x১৫০০
৭	টেলিফোন	১৫০০x১৫০০
৮	কফি	১৫০০x১৫০০
৯	স্মোকিং	১৫০০x১৫০০
১০	স্টোরেজ	১৫০০x১৫০০
১১	অফিস	১৫০০x১৫০০
১২	কনফারেন্স	১৫০০x১৫০০
১৩	রিসেপশন	১৫০০x১৫০০
১৪	ইন্ট্রো	১৫০০x১৫০০
১৫	ইন্ট্রো	১৫০০x১৫০০
১৬	ইন্ট্রো	১৫০০x১৫০০
১৭	ইন্ট্রো	১৫০০x১৫০০
১৮	ইন্ট্রো	১৫০০x১৫০০
১৯	ইন্ট্রো	১৫০০x১৫০০
২০	ইন্ট্রো	১৫০০x১৫০০
২১	ইন্ট্রো	১৫০০x১৫০০
২২	ইন্ট্রো	১৫০০x১৫০০
২৩	ইন্ট্রো	১৫০০x১৫০০
২৪	ইন্ট্রো	১৫০০x১৫০০
২৫	ইন্ট্রো	১৫০০x১৫০০
২৬	ইন্ট্রো	১৫০০x১৫০০
২৭	ইন্ট্রো	১৫০০x১৫০০
২৮	ইন্ট্রো	১৫০০x১৫০০

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KEY PLAN

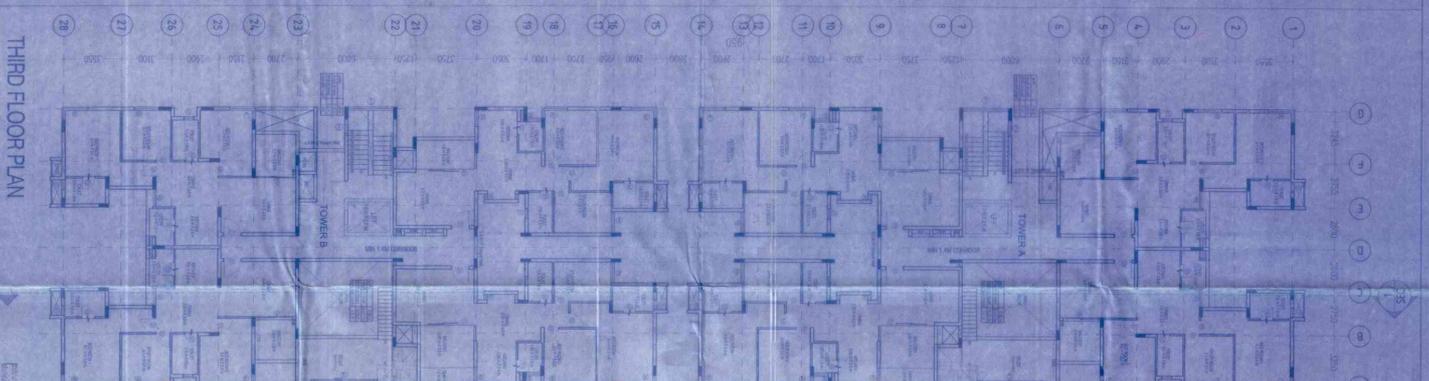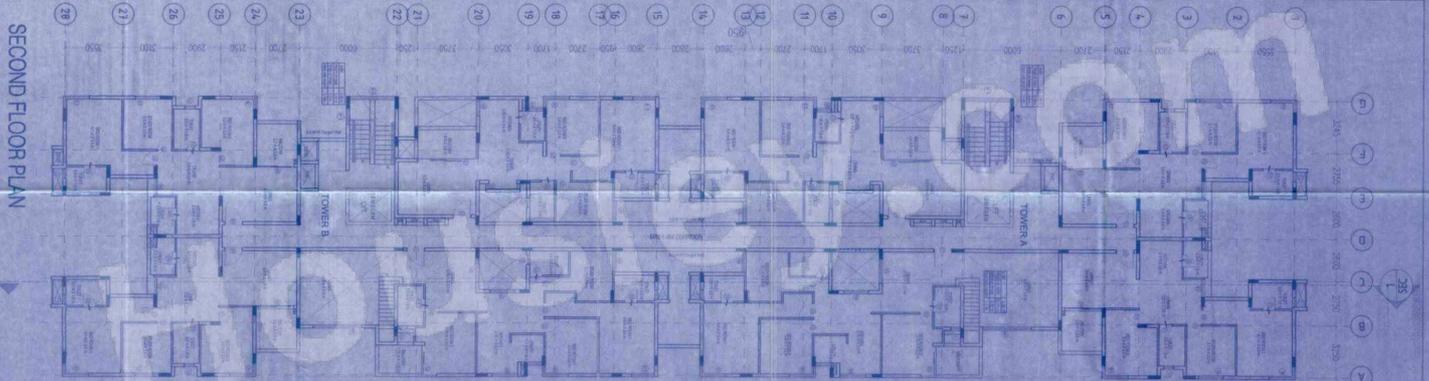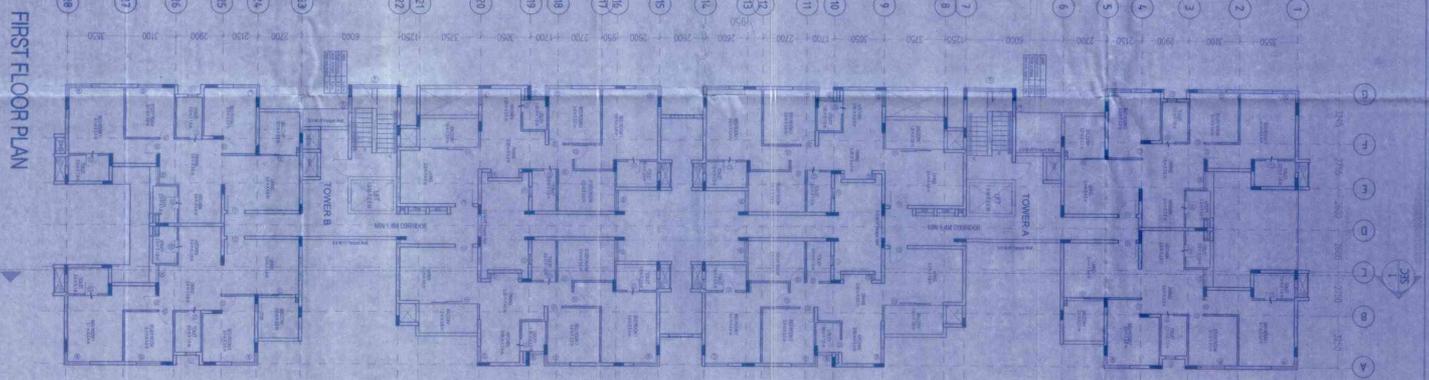

DOOR WINDOW LEGEND

TYPE	RESISTANCE	SIZE
D001	1.1 X 2.1	1.1 X 2.1
D01	0.8 X 2.1	0.8 X 2.1
D02	0.8 X 2.1	0.8 X 2.1
D03	0.8 X 2.1	0.8 X 2.1
D04	2.1 X 2.1	2.1 X 2.1
D05	2.1 X 2.1	2.1 X 2.1
D06	2.1 X 2.1	2.1 X 2.1
D100	2.1 X 2.1	2.1 X 2.1

CLIENT: BRIGADE ENTERPRISE LTD.

OWNER'S SIGNATURE: [Signature]

PROJECT TITLE: Proposed Residential Development at 250, Dr. Rajendra Prasad, Madhyama Residential, Dhaka-1000.

ARCHITECT'S SIGNATURE: [Signature]

DATE: 24-02-2022

SCALE: 1:100

ORIENTATION: [North Arrow]

SHEET NO. 03 OF 07

DRAWING NO. 03

DATE: 24-02-2022

SCALE: 1:100

ORIENTATION: [North Arrow]

MINDSPACE
 ARCHITECTS & ENGINEERS
 465, RAJSHREE ROAD, RAJSHREE, DHAKA.
 Contact: 01711-111111, 01711-111111
 Email: info@mindspace.com

DATE: 15/07/2019

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THE ARCHITECT'S LIABILITY IS LIMITED TO THE DESIGN AND CONSTRUCTION OF THE BUILDING AND DOES NOT EXTEND TO ANY OTHER MATTER.

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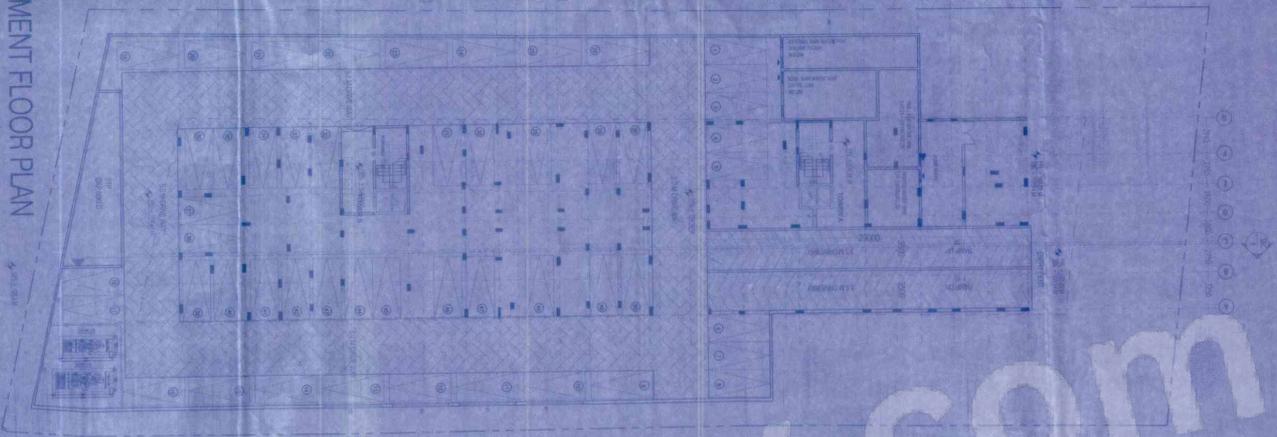
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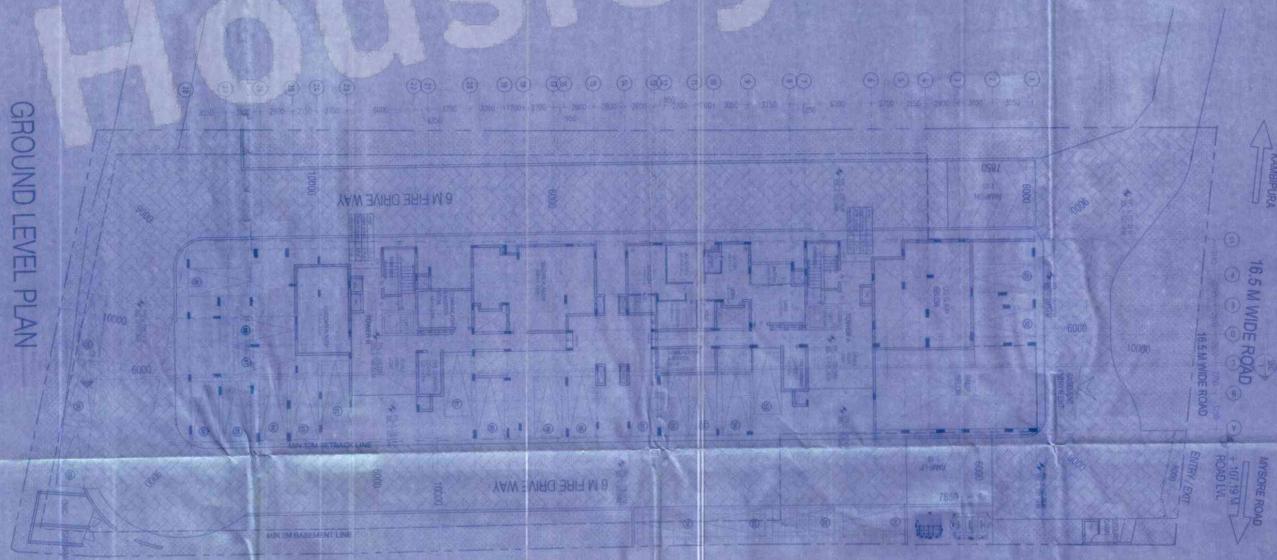
THE ARCHITECT'S LIABILITY IS LIMITED TO THE DESIGN AND CONSTRUCTION OF THE BUILDING AND DOES NOT EXTEND TO ANY OTHER MATTER.

NO.	REVISION	DATE
1	ISSUED FOR PERMIT	15/07/2019
2	ISSUED FOR PERMIT	15/07/2019
3	ISSUED FOR PERMIT	15/07/2019

BASEMENT FLOOR PLAN



GROUND LEVEL PLAN



NO.	DESCRIPTION	QTY	UNIT	REMARKS
1	CONCRETE	1000	M ³	
2	STEEL	500	KG	
3	BRICK	2000	M ²	
4	ROOFING	1000	M ²	
5	PAINT	500	L	
6	GLASS	100	M ²	
7	DOOR	10	NO.	
8	WINDOW	20	NO.	
9	STAIR	1	NO.	
10	LIFT	1	NO.	
11	ELECTRICAL	1000	M	
12	PLUMBING	1000	M	
13	MECHANICAL	1000	M	
14	LANDSCAPE	1000	M ²	
15	CONCRETE	1000	M ³	
16	STEEL	500	KG	
17	BRICK	2000	M ²	
18	ROOFING	1000	M ²	
19	PAINT	500	L	
20	GLASS	100	M ²	
21	DOOR	10	NO.	
22	WINDOW	20	NO.	
23	STAIR	1	NO.	
24	LIFT	1	NO.	
25	ELECTRICAL	1000	M	
26	PLUMBING	1000	M	
27	MECHANICAL	1000	M	
28	LANDSCAPE	1000	M ²	
29	CONCRETE	1000	M ³	
30	STEEL	500	KG	
31	BRICK	2000	M ²	
32	ROOFING	1000	M ²	
33	PAINT	500	L	
34	GLASS	100	M ²	
35	DOOR	10	NO.	
36	WINDOW	20	NO.	
37	STAIR	1	NO.	
38	LIFT	1	NO.	
39	ELECTRICAL	1000	M	
40	PLUMBING	1000	M	
41	MECHANICAL	1000	M	
42	LANDSCAPE	1000	M ²	
43	CONCRETE	1000	M ³	
44	STEEL	500	KG	
45	BRICK	2000	M ²	
46	ROOFING	1000	M ²	
47	PAINT	500	L	
48	GLASS	100	M ²	
49	DOOR	10	NO.	
50	WINDOW	20	NO.	
51	STAIR	1	NO.	
52	LIFT	1	NO.	
53	ELECTRICAL	1000	M	
54	PLUMBING	1000	M	
55	MECHANICAL	1000	M	
56	LANDSCAPE	1000	M ²	
57	CONCRETE	1000	M ³	
58	STEEL	500	KG	
59	BRICK	2000	M ²	
60	ROOFING	1000	M ²	
61	PAINT	500	L	
62	GLASS	100	M ²	
63	DOOR	10	NO.	
64	WINDOW	20	NO.	
65	STAIR	1	NO.	
66	LIFT	1	NO.	
67	ELECTRICAL	1000	M	
68	PLUMBING	1000	M	
69	MECHANICAL	1000	M	
70	LANDSCAPE	1000	M ²	
71	CONCRETE	1000	M ³	
72	STEEL	500	KG	
73	BRICK	2000	M ²	
74	ROOFING	1000	M ²	
75	PAINT	500	L	
76	GLASS	100	M ²	
77	DOOR	10	NO.	
78	WINDOW	20	NO.	
79	STAIR	1	NO.	
80	LIFT	1	NO.	
81	ELECTRICAL	1000	M	
82	PLUMBING	1000	M	
83	MECHANICAL	1000	M	
84	LANDSCAPE	1000	M ²	
85	CONCRETE	1000	M ³	
86	STEEL	500	KG	
87	BRICK	2000	M ²	
88	ROOFING	1000	M ²	
89	PAINT	500	L	
90	GLASS	100	M ²	
91	DOOR	10	NO.	
92	WINDOW	20	NO.	
93	STAIR	1	NO.	
94	LIFT	1	NO.	
95	ELECTRICAL	1000	M	
96	PLUMBING	1000	M	
97	MECHANICAL	1000	M	
98	LANDSCAPE	1000	M ²	
99	CONCRETE	1000	M ³	
100	STEEL	500	KG	

PROJECT INFORMATION

PROJECT NAME: [REDACTED]

CLIENT: [REDACTED]

PROJECT ADDRESS: [REDACTED]

DATE: 15/07/2019

SCALE: 1:100

DESIGNER: [REDACTED]

ARCHITECT: [REDACTED]

ENGINEER: [REDACTED]

LANDSCAPE ARCHITECT: [REDACTED]

MECHANICAL ENGINEER: [REDACTED]

ELECTRICAL ENGINEER: [REDACTED]

PLUMBING ENGINEER: [REDACTED]

CONSTRUCTION SUPERVISOR: [REDACTED]

PROJECT INFORMATION

PROJECT NAME: [REDACTED]

CLIENT: [REDACTED]

PROJECT ADDRESS: [REDACTED]

DATE: 15/07/2019

SCALE: 1:100

DESIGNER: [REDACTED]

ARCHITECT: [REDACTED]

ENGINEER: [REDACTED]

LANDSCAPE ARCHITECT: [REDACTED]

MECHANICAL ENGINEER: [REDACTED]

ELECTRICAL ENGINEER: [REDACTED]

PLUMBING ENGINEER: [REDACTED]

CONSTRUCTION SUPERVISOR: [REDACTED]

PROJECT INFORMATION

PROJECT NAME: [REDACTED]

CLIENT: [REDACTED]

PROJECT ADDRESS: [REDACTED]

DATE: 15/07/2019

SCALE: 1:100

DESIGNER: [REDACTED]

ARCHITECT: [REDACTED]

ENGINEER: [REDACTED]

LANDSCAPE ARCHITECT: [REDACTED]

MECHANICAL ENGINEER: [REDACTED]

ELECTRICAL ENGINEER: [REDACTED]

PLUMBING ENGINEER: [REDACTED]

CONSTRUCTION SUPERVISOR: [REDACTED]

The floor plan shows the proposed layout of the building. It includes the following details:

- Overall dimensions and setbacks.
- Room layouts and furniture placement.
- Structural grid lines and column locations.
- Staircases and elevator shafts.
- Service areas such as kitchen, bathroom, and utility rooms.
- External features like terraces and landscaping.


The plan is drawn to a scale of 1:100. The drawing shows the building's footprint within the site boundaries. The setbacks from the boundaries are as follows:

- Front setback: 10.00m
- Rear setback: 10.00m
- Side setbacks: 5.00m

The drawing is a technical representation of the proposed building. It shows the structural layout, including columns, beams, and walls. The rooms are labeled with their respective names and dimensions.

NO.	DESCRIPTION	UNIT
1	Overall Area	100.00 sqm
2	Building Area	80.00 sqm
3	Open Area	20.00 sqm
4	Other	0.00 sqm
5	Total	100.00 sqm

Housiey.com

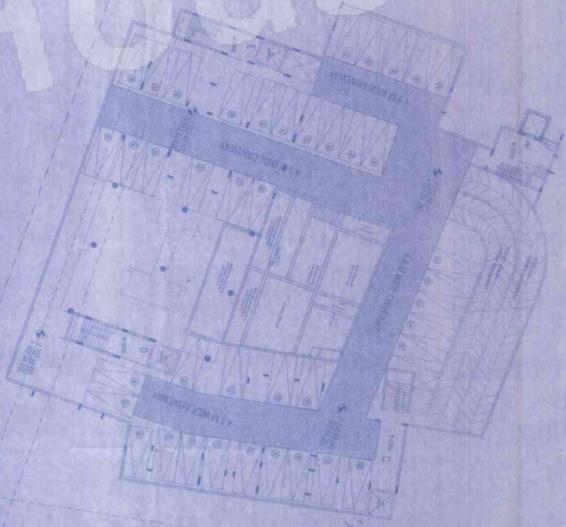

DOOR WINDOW LEGEND

TYPE	DESCRIPTION	CODE
1	DOOR	101
2	WINDOW	201
3	GLASS DOOR	301
4	GLASS WINDOW	401
5	SCREEN DOOR	501
6	SCREEN WINDOW	601
7	SLIDING DOOR	701
8	SLIDING WINDOW	801
9	SHOWER DOOR	901
10	SHOWER WINDOW	1001

LEGEND

SETBACK LINE

CLIENT
 B. Raju Enterprises Ltd, 2nd/3rd/4th floor,
 26/1 D9, Kallurum Road, Valluvar Nagar, Bangalore-560025

ARCHITECT'S SIGNATURE

PROJECT TITLE
 PROPOSED RESIDENTIAL DEVELOPMENT
 SY No. 2482
 KAMBIPURAY VILLAGE
 BANGALORE SOUTH

DRAWING TITLE
 PLAN AT 1:100.34 M LVL

NO.	DESCRIPTION	UNIT
1	Overall Area	100.00 sqm
2	Building Area	80.00 sqm
3	Open Area	20.00 sqm
4	Other	0.00 sqm
5	Total	100.00 sqm

ARCHITECTS + ENGINEERS
 M
 #10, KALPANA GANNA ROAD, HALIY 2ND STAGE,
 SANJAYNAGAR, BANGALORE-560 042
 Phone No: 082 2591 5301/02
 www.independentarchitects.com

1. The owner shall be responsible for obtaining all necessary permits and approvals from the relevant authorities for the construction of the proposed development.

2. The owner shall be responsible for providing all necessary information and documents to the relevant authorities for the construction of the proposed development.

3. The owner shall be responsible for providing all necessary information and documents to the relevant authorities for the construction of the proposed development.

4. The owner shall be responsible for providing all necessary information and documents to the relevant authorities for the construction of the proposed development.

5. The owner shall be responsible for providing all necessary information and documents to the relevant authorities for the construction of the proposed development.

6. The owner shall be responsible for providing all necessary information and documents to the relevant authorities for the construction of the proposed development.

7. The owner shall be responsible for providing all necessary information and documents to the relevant authorities for the construction of the proposed development.

8. The owner shall be responsible for providing all necessary information and documents to the relevant authorities for the construction of the proposed development.


9. The owner shall be responsible for providing all necessary information and documents to the relevant authorities for the construction of the proposed development.

10. The owner shall be responsible for providing all necessary information and documents to the relevant authorities for the construction of the proposed development.

11. The owner shall be responsible for providing all necessary information and documents to the relevant authorities for the construction of the proposed development.

No.	Description	Quantity	Unit
1	Concrete	1000	m ³
2	Steel Reinforcement	500	kg
3	Brickwork	2000	m ²
4	Plaster	1500	m ²
5	Paint	100	kg
6	Roof Tiles	5000	m ²
7	Windows	10	nos
8	Doors	5	nos
9	Sanitary Ware	10	nos
10	Electrical Fittings	100	nos
11	Water Supply	100	m
12	Drainage	100	m
13	Landscaping	100	m ²
14	Site Preparation	100	m ²
15	Foundation	100	m ²
16	Walls	100	m ²
17	Floors	100	m ²
18	Roof	100	m ²
19	Stairs	100	m ²
20	Other	100	m ²

HOCHSIEY.COM

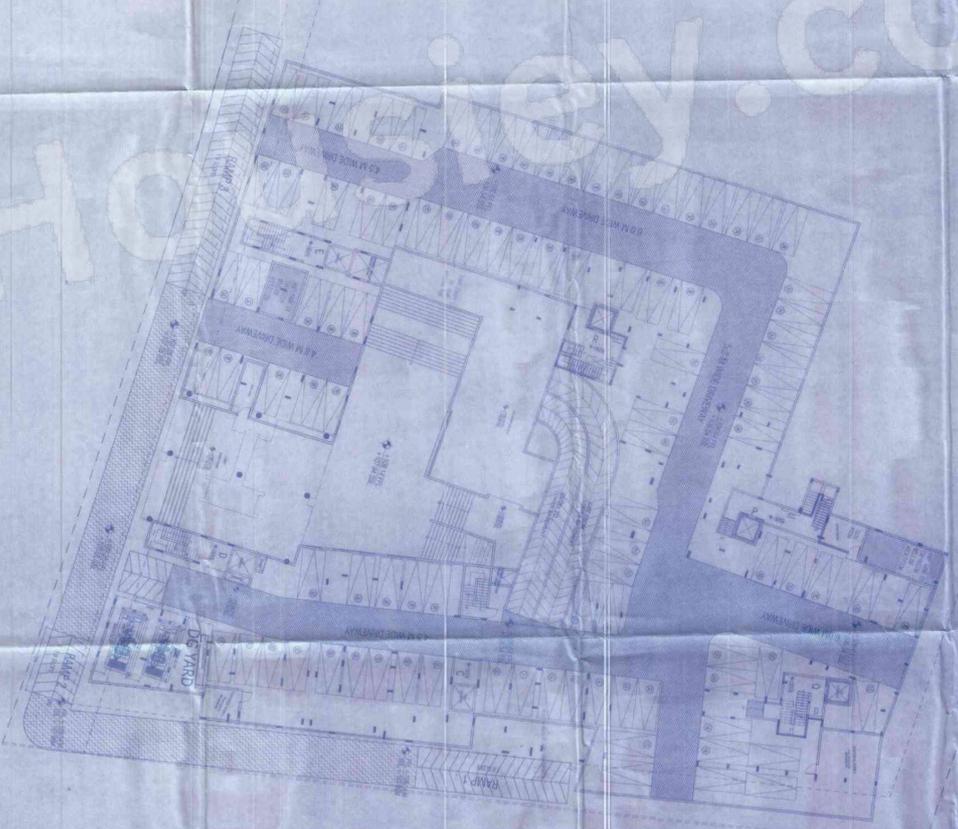

16.5 M ROAD

Architects + Interiors + Engineers
 4/03, KUALA CHINA ROAD, KAWA 2ND STAGE
 Selayang, Selangor 68100
 Phone No: 03-251 5501/2
 www.architectsinteriors.com

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 4/03, KUALA CHINA ROAD, KAWA 2ND STAGE
 Selayang, Selangor 68100
 Phone No: 03-251 5501/2
 www.architectsinteriors.com

PROJECT TITLE	PROPOSED RESIDENTIAL DEVELOPMENT
CLIENT	Grand Enterprise Ltd, 208A, Jalan Pagar, Batu Tiga, Selangor, Malaysia
ARCHITECT'S SIGNATURE	[Signature]
HANDOVER ARCHITECTS	REG. NO: BCCRS. 3/BA/281/019-20
DRAWING TITLE	PLAN AT +08.54 M LVL
SHEET NO.	02 OF 12
DATE	20-05-2022
SCALE	1:175
ORIENTATION	[Compass rose showing North]

ARCHITECT'S SIGNATURE
 HANDOVER ARCHITECTS
 REG. NO: BCCRS. 3/BA/281/019-20

CLIENT
 Grand Enterprise Ltd, 208A, Jalan Pagar, Batu Tiga, Selangor, Malaysia

PROJECT TITLE
 PROPOSED RESIDENTIAL DEVELOPMENT

CLIENT
 Grand Enterprise Ltd, 208A, Jalan Pagar, Batu Tiga, Selangor, Malaysia

NO.	DATE	DESCRIPTION	BY
1	20/05/2022	ISSUED FOR PERMIT	HA
2	20/05/2022	ISSUED FOR PERMIT	HA
3	20/05/2022	ISSUED FOR PERMIT	HA
4	20/05/2022	ISSUED FOR PERMIT	HA
5	20/05/2022	ISSUED FOR PERMIT	HA
6	20/05/2022	ISSUED FOR PERMIT	HA
7	20/05/2022	ISSUED FOR PERMIT	HA
8	20/05/2022	ISSUED FOR PERMIT	HA
9	20/05/2022	ISSUED FOR PERMIT	HA
10	20/05/2022	ISSUED FOR PERMIT	HA



PROJECT TITLE
 PROPOSED RESIDENTIAL DEVELOPMENT

CLIENT
 Grand Enterprise Ltd, 208A, Jalan Pagar, Batu Tiga, Selangor, Malaysia

ARCHITECT'S SIGNATURE
 HANDOVER ARCHITECTS
 REG. NO: BCCRS. 3/BA/281/019-20

DRAWING TITLE
 PLAN AT +08.54 M LVL

SHEET NO.
 02 OF 12

DATE
 20-05-2022

SCALE
 1:175

ORIENTATION
 [Compass rose showing North]

KEY PLAN



DOORS WINDOW SCHEDULE

NO.	DESCRIPTION	UNIT	QTY
1	DOOR	SQ. FT.	1200
2	WINDOW	SQ. FT.	1800
3	GLASS	SQ. FT.	1800
4	ALUMINIUM	SQ. FT.	1800
5	WOOD	SQ. FT.	1800
6	IRON	SQ. FT.	1800
7	STEEL	SQ. FT.	1800
8	CERAMIC	SQ. FT.	1800
9	PLASTER	SQ. FT.	1800
10	PAINT	SQ. FT.	1800
11	ROOFING	SQ. FT.	1800
12	CONCRETE	SQ. FT.	1800
13	FOUNDATION	SQ. FT.	1800
14	WATER	SQ. FT.	1800
15	ELECTRICAL	SQ. FT.	1800
16	MECHANICAL	SQ. FT.	1800
17	LANDSCAPE	SQ. FT.	1800
18	FINISH	SQ. FT.	1800
19	FIXTURES	SQ. FT.	1800
20	APPLIANCES	SQ. FT.	1800

LEGEND

SETBACK LINE

CLIENT

Brigade Enterprises Ltd. 20th & 21st Floor,
World Trade Center, Brigade Gateway Campus,
261 Dr. Rajkumar Road, Malleshwara-560018,
Bangalore-560015

ARCHITECT'S SIGNATURE

MINDSPACE ARCHITECTS
BCC No: BCP/B/3/BA/2012/19-20

PROJECT TITLE

PROPOSED RESIDENTIAL DEVELOPMENT
BY No. 28B2
KAMBUPURA VILLAGE, KENGERI HOBLI,
BANGALORE SOUTH

DRAWING TITLE

PLAN AT 1:16.52 M/D/L

SHEET NO.

06 OF 12

DRAWING NO.

05

DATE

23.05.2022

SCALE

ORIENTATION

1:175



N

ARCHITECTS + INTERIORS + ENGINEERS

#105, KALPANA CHAMRAJODI, T.M.V. 2nd STAGE,
SALURVAGAR, BANGALORE-560104.
Phone No: 080-2851 3507/02
www.mindspacearchitects.com



Architects + Interiors + Engineers
#105, Kalpana Chamrajudi, T.M.V. 2nd Stage,
Salurvagar, Bangalore-560104
Phone No: 080-2851 3507/02
www.mindspacearchitects.com

NOTES:
1. ALL DIMENSIONS ARE IN METERS UNLESS OTHERWISE SPECIFIED.
2. THE SETBACKS ARE AS PER THE REGULATIONS.
3. THE BUILDING SHALL BE CONSTRUCTED AS PER THE APPROVED PLAN.
4. THE FOUNDATION SHALL BE AS PER THE APPROVED PLAN.
5. THE ROOFING SHALL BE AS PER THE APPROVED PLAN.
6. THE FINISHES SHALL BE AS PER THE APPROVED PLAN.
7. THE FIXTURES AND APPLIANCES SHALL BE AS PER THE APPROVED PLAN.
8. THE LANDSCAPE SHALL BE AS PER THE APPROVED PLAN.
9. THE ELECTRICAL AND MECHANICAL SHALL BE AS PER THE APPROVED PLAN.
10. THE WATER SUPPLY SHALL BE AS PER THE APPROVED PLAN.
11. THE SEWERAGE SHALL BE AS PER THE APPROVED PLAN.
12. THE RAINWATER SHALL BE AS PER THE APPROVED PLAN.
13. THE VENTILATION SHALL BE AS PER THE APPROVED PLAN.
14. THE LIGHTING SHALL BE AS PER THE APPROVED PLAN.
15. THE SOUND INSULATION SHALL BE AS PER THE APPROVED PLAN.
16. THE FIRE SAFETY SHALL BE AS PER THE APPROVED PLAN.
17. THE ACCESSIBILITY SHALL BE AS PER THE APPROVED PLAN.
18. THE SECURITY SHALL BE AS PER THE APPROVED PLAN.
19. THE MAINTENANCE SHALL BE AS PER THE APPROVED PLAN.
20. THE OPERATION SHALL BE AS PER THE APPROVED PLAN.

1. The owner shall be responsible for obtaining all necessary permits and approvals from the relevant authorities. The architect shall provide all necessary information and documentation to the owner to facilitate the permit application process.

2. The owner shall be responsible for providing all necessary site information and data to the architect, including but not limited to, site location, access, and existing conditions. The architect shall provide all necessary information and documentation to the owner to facilitate the permit application process.

3. The architect shall be responsible for providing all necessary design and construction documents to the owner, including but not limited to, site plan, floor plan, and construction details. The architect shall also be responsible for providing all necessary information and documentation to the owner to facilitate the permit application process.

4. The owner shall be responsible for providing all necessary construction materials and labor to the architect. The architect shall be responsible for providing all necessary supervision and coordination during the construction process.

5. The architect shall be responsible for providing all necessary information and documentation to the owner to facilitate the permit application process. The architect shall also be responsible for providing all necessary information and documentation to the owner to facilitate the construction process.

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NO.	REVISION	DATE	BY
1	ISSUED FOR PERMIT	2022-05-01	ARCHITECT
2	ISSUED FOR CONSTRUCTION	2022-05-01	ARCHITECT
3	ISSUED FOR CONSTRUCTION	2022-05-01	ARCHITECT
4	ISSUED FOR CONSTRUCTION	2022-05-01	ARCHITECT
5	ISSUED FOR CONSTRUCTION	2022-05-01	ARCHITECT
6	ISSUED FOR CONSTRUCTION	2022-05-01	ARCHITECT
7	ISSUED FOR CONSTRUCTION	2022-05-01	ARCHITECT
8	ISSUED FOR CONSTRUCTION	2022-05-01	ARCHITECT
9	ISSUED FOR CONSTRUCTION	2022-05-01	ARCHITECT
10	ISSUED FOR CONSTRUCTION	2022-05-01	ARCHITECT



DOOR WINDOW LEDEND

Selected by door in meters

NO.	TYPE	AREA	PERCENTAGE
1	DOOR	1.50	0.10
2	WINDOW	14.50	1.00
3	GLASS	13.00	0.90
4	SCREEN	0.50	0.04
5	SHUTTER	0.50	0.04
6	OTHER	0.50	0.04
7	TOTAL	15.50	1.10

LEGEND

BETUOK LUR

CLIENT

Prinsipal Enterprise, Ltd. 2014, Jalan Bina, Medan, Sumatera Utara, Indonesia

ARCHITECTS SIGNATURE

MINOSPAC ARCHITECTS
BCC no. 02/CL.3.14.18/2019-20

PROJECT TITLE

PROPOSED RESIDENTIAL DEVELOPMENT
S/N No. 24/2
KAMPURIA VILLAGE - KENGERI HOBI
BANGKALORE SOUTH

DRAWING TITLE

PLAN A + 128.08 M LVL

SHEET NO. 08 OF 12

DRAWING NO. 08

DATE 20-05-2022

SCALE 1:175

ORIENTATION

ARCHITECTS + INTERIORS + ENGINEERS

#88, WILIRAN CHINIAU ROAD, KAWA 2ND STAGE,
SALAWANG, BANGKALORE, 560 004
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