


This cannot be approved to the previous Plans. Letter No. SA/PT/10/16/2012/2023/AFS dated 02.10.2012

stamp of approval of plan

Approved Subject to the condition Mentioned in this office permission Letter No. SA/PT/10/16/2012/2023/AFS DATED 08-SEP-2012
 Executive Engineer Slum Rehabilitation Authority Brihanmumbai

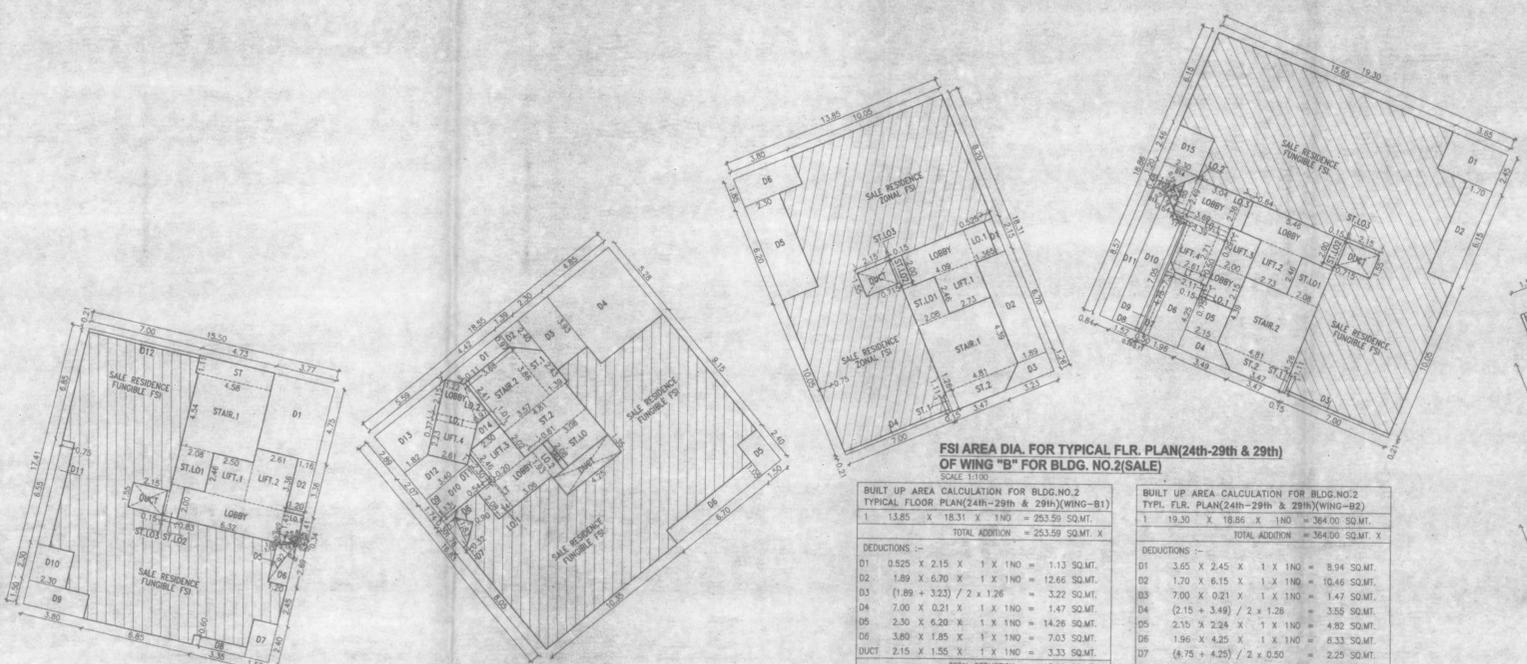

FSI AREA DIA. FOR TYPICAL FLR. PLAN(24th-29th) OF WING "A" FOR BLDG. NO.2(SALE)
 SCALE 1:100

BUILT UP AREA CALCULATION FOR BLDG.NO.2 TYPICAL FLOOR PLAN(24th-29th)(WING-A1)	
1	15.50 X 17.41 X 1NO = 269.86 SQ.MT. X
TOTAL ADDITION = 269.86 SQ.MT. X	
DEDUCTIONS :-	
D1	3.77 X 4.75 X 1 X 1NO = 17.91 SQ.MT.
D2	1.16 X 3.36 X 1 X 1NO = 3.90 SQ.MT.
D3	0.53 X 0.20 X 0.5 X 1NO = 0.05 SQ.MT.
D4	0.53 X 0.11 X 0.5 X 1NO = 0.03 SQ.MT.
D5	2.92 X 0.89 X 0.5 X 1NO = 1.30 SQ.MT.
D6	(0.07 + 1.20) / 2 X 2.69 = 1.71 SQ.MT.
D7	1.50 X 2.40 X 1 X 1NO = 3.60 SQ.MT.
D8	3.35 X 0.60 X 1 X 1NO = 2.01 SQ.MT.
D9	3.80 X 1.50 X 1 X 1NO = 5.70 SQ.MT.
D10	2.30 X 2.30 X 1 X 1NO = 5.29 SQ.MT.
D11	0.75 X 6.85 X 1 X 1NO = 5.14 SQ.MT.
D12	7.00 X 0.21 X 1 X 1NO = 1.47 SQ.MT.
DUCT	2.15 X 1.55 X 1 X 1NO = 3.33 SQ.MT.
TOTAL DEDUCTION = 51.21 SQ.MT.X1	
TOTAL BUILT UP AREA [X - Y1] = 218.65 SQ.MT.X1	

STAIRCASE & LIFT AREA CAL. FOR BLDG.NO.2-TYPICAL FLOOR PLAN(24th-29th)(WING-A1)	
STAR.1	4.58 X 4.54 X 1NO = 20.79 SQ.MT.
ST	4.73 X 1.11 X 1NO = 5.25 SQ.MT.
ST.LO.1	2.06 X 2.46 X 1NO = 5.12 SQ.MT.
ST.LO.2	0.83 X 2.00 X 1NO = 1.66 SQ.MT.
ST.LO.3	0.15 X 1.55 X 1NO = 0.23 SQ.MT.
LIFT.1	2.50 X 2.46 X 1NO = 6.15 SQ.MT.
LIFT.2	2.61 X 3.36 X 1NO = 8.77 SQ.MT.
LOBBY	6.32 X 2.00 X 1NO = 12.64 SQ.MT.
LO.1	1.20 X 1.41 X 1NO = 1.69 SQ.MT.
LO.2	1.20 X 0.25 X 0.5NO = 0.15 SQ.MT.
LO.3	1.06 X 0.56 X 0.5NO = 0.30 SQ.MT.
LO.4	1.12 X 0.14 X 0.5NO = 0.08 SQ.MT.
LO.5	1.19 X 0.13 X 0.5NO = 0.08 SQ.MT.
TOTAL STAIR. & LIFT AREA PER FL. = 62.91 SQ.MT.	
NET B.U.AREA OF TYP. FLR. OF SALE RESIDENCE (218.65-62.91) = 155.74 SQ.MT.	

BUILT UP AREA CALCULATION FOR BLDG.NO.2 TYPICAL FLOOR PLAN(24th-29th)(WING-B1)	
1	18.55 X 18.83 X 1NO = 312.20 SQ.MT. X
TOTAL ADDITION = 312.20 SQ.MT. X	
DEDUCTIONS :-	
D1	(4.42 + 3.68) / 2 X 0.97 = 3.93 SQ.MT.
D2	(0.97 + 2.40) / 2 X 1.39 = 2.34 SQ.MT.
D3	2.30 X 3.93 X 1 X 1NO = 9.04 SQ.MT.
D4	4.85 X 5.28 X 1 X 1NO = 25.61 SQ.MT.
D5	1.50 X 2.40 X 1 X 1NO = 3.60 SQ.MT.
D6	1.05 X 6.70 X 1 X 1NO = 7.04 SQ.MT.
D7	(0.74 + 0.32) / 2 X 1.78 = 0.94 SQ.MT.
D8	1.83 X 0.30 X 0.5 X 1NO = 0.82 SQ.MT.
D9	(1.13 + 0.74) / 2 X 0.30 = 0.28 SQ.MT.
D10	3.40 X 1.74 X 1 X 1NO = 5.92 SQ.MT.
D11	(1.74 + 2.30) / 2 X 0.54 = 1.08 SQ.MT.
D12	(1.82 + 3.40) / 2 X 2.07 = 5.40 SQ.MT.
D13	(1.82 + 5.59) / 2 X 2.89 = 10.71 SQ.MT.
D14	(0.97 + 2.30) / 2 X 1.01 = 1.65 SQ.MT.
DUCT	4.25 X 1.55 X 1 X 1NO = 6.59 SQ.MT.
TOTAL DEDUCTION = 84.11 SQ.MT.X1	
TOTAL BUILT UP AREA [X - Y1] = 228.09 SQ.MT.X1	

STAIRCASE & LIFT AREA CAL. FOR BLDG.NO.2-TYPICAL FLOOR PLAN(24th-29th)(WING-B1)	
STAR.1	4.81 X 4.39 X 1NO = 21.12 SQ.MT.
ST.1	0.15 X 1.11 X 1NO = 0.17 SQ.MT.
ST.2	(4.81 + 3.47) / 2 X 1.26 = 5.22 SQ.MT.
ST.LO.1	2.08 X 2.46 X 1NO = 5.12 SQ.MT.
ST.LO.2	0.715 X 2.00 X 1NO = 1.43 SQ.MT.
ST.LO.3	0.15 X 1.55 X 1NO = 0.23 SQ.MT.
LIFT.1	2.73 X 2.46 X 1NO = 6.72 SQ.MT.
LIFT.2	2.73 X 2.46 X 1NO = 6.72 SQ.MT.
LOBBY	5.46 X 2.00 X 1NO = 10.92 SQ.MT.
LIFT.3	2.00 X 2.46 X 1NO = 4.92 SQ.MT.
LIFT.4	2.00 X 2.15 X 1NO = 4.30 SQ.MT.
LO.1	0.15 X 0.75 X 1NO = 0.11 SQ.MT.
LIFT.4	2.61 X 2.71 X 1NO = 7.07 SQ.MT.
LT	(2.31 + 2.61) / 2 X 0.50 = 1.16 SQ.MT.
LOBBY	3.04 X 2.36 X 1NO = 7.17 SQ.MT.
LO.1	(3.39 + 3.69) / 2 X 0.29 = 1.03 SQ.MT.
LO.2	(1.85 + 2.49) / 2 X 0.64 = 1.39 SQ.MT.
LO.3	0.64 X 2.00 X 1NO = 1.28 SQ.MT.
LO.4	0.55 X 1.10 X 0.5NO = 0.30 SQ.MT.
LO.5	(0.63 + 1.16) / 2 X 0.53 = 0.47 SQ.MT.
LO.6	(0.78 + 0.63) / 2 X 0.15 = 0.10 SQ.MT.
LO.7	0.52 X 0.26 X 0.5NO = 0.07 SQ.MT.
TOTAL STAIR. & LIFT AREA PER FL. = 80.32 SQ.MT.	
NET B.U.AREA OF TYP. FLR. OF SALE RESIDENCE (228.09-80.32) = 147.77 SQ.MT.	



FSI AREA DIA. FOR TYPICAL FLR. PLAN(24th-29th) OF WING "B" FOR BLDG. NO.2(SALE)
 SCALE 1:100

BUILT UP AREA CALCULATION FOR BLDG.NO.2 TYPICAL FLOOR PLAN(24th-29th & 29th)(WING-B1)	
1	13.85 X 18.31 X 1NO = 253.59 SQ.MT. X
TOTAL ADDITION = 253.59 SQ.MT. X	
DEDUCTIONS :-	
D1	0.525 X 2.15 X 1 X 1NO = 1.13 SQ.MT.
D2	1.89 X 6.70 X 1 X 1NO = 12.66 SQ.MT.
D3	(1.89 + 3.23) / 2 X 1.26 = 3.22 SQ.MT.
D4	7.00 X 0.21 X 1 X 1NO = 1.47 SQ.MT.
D5	2.30 X 6.20 X 1 X 1NO = 14.26 SQ.MT.
D6	3.80 X 1.85 X 1 X 1NO = 7.03 SQ.MT.
DUCT	2.15 X 1.55 X 1 X 1NO = 3.33 SQ.MT.
TOTAL DEDUCTION = 43.10 SQ.MT.X1	
TOTAL BUILT UP AREA [X - Y1] = 210.49 SQ.MT.X1	

STAIRCASE & LIFT AREA CAL. FOR BLDG.NO.2-TYPICAL FLOOR PLAN(24th-29th & 29th)(WING-B1)	
STAR.1	4.81 X 4.39 X 1NO = 21.12 SQ.MT.
ST.1	0.15 X 1.11 X 1NO = 0.17 SQ.MT.
ST.2	(4.81 + 3.47) / 2 X 1.26 = 5.22 SQ.MT.
ST.LO.1	2.08 X 2.46 X 1NO = 5.12 SQ.MT.
ST.LO.2	0.715 X 2.00 X 1NO = 1.43 SQ.MT.
ST.LO.3	0.15 X 1.55 X 1NO = 0.23 SQ.MT.
LIFT.1	2.73 X 2.46 X 1NO = 6.72 SQ.MT.
LIFT.2	2.73 X 2.46 X 1NO = 6.72 SQ.MT.
LOBBY	4.09 X 2.00 X 1NO = 8.18 SQ.MT.
LO.1	1.365 X 2.15 X 1NO = 2.93 SQ.MT.
TOTAL STAIR. & LIFT AREA PER FL. = 51.12 SQ.MT.	
NET B.U.AREA OF TYP. FLR. OF SALE RESIDENCE (210.49-51.12) = 159.37 SQ.MT.	

BUILT UP AREA CALCULATION FOR BLDG.NO.2 TYPICAL FLOOR PLAN(24th-29th & 29th)(WING-B2)	
1	19.30 X 18.85 X 1NO = 364.00 SQ.MT. X
TOTAL ADDITION = 364.00 SQ.MT. X	
DEDUCTIONS :-	
D1	3.65 X 2.45 X 1 X 1NO = 8.94 SQ.MT.
D2	1.70 X 6.15 X 1 X 1NO = 10.46 SQ.MT.
D3	7.00 X 0.21 X 1 X 1NO = 1.47 SQ.MT.
D4	(2.15 + 3.49) / 2 X 1.26 = 3.58 SQ.MT.
D5	2.15 X 2.24 X 1 X 1NO = 4.82 SQ.MT.
D6	1.96 X 4.25 X 1 X 1NO = 8.33 SQ.MT.
D7	(6.75 + 4.25) / 2 X 0.50 = 2.25 SQ.MT.
D8	0.11 X 7.31 X 1 X 1NO = 0.80 SQ.MT.
D9	(7.05 + 7.31) / 2 X 0.26 = 1.87 SQ.MT.
D10	(7.05 + 8.57) / 2 X 1.58 = 11.87 SQ.MT.
D11	0.84 X 8.57 X 1 X 1NO = 7.20 SQ.MT.
D12	0.55 X 0.15 X 0.5 X 1NO = 0.04 SQ.MT.
D13	(0.84 + 1.10) / 2 X 0.48 = 0.46 SQ.MT.
D14	(1.10 + 2.30) / 2 X 1.29 = 2.04 SQ.MT.
D15	2.30 X 2.46 X 1 X 1NO = 5.66 SQ.MT.
DUCT	2.15 X 1.55 X 1 X 1NO = 3.33 SQ.MT.
TOTAL DEDUCTION = 73.09 SQ.MT.X1	
TOTAL BUILT UP AREA [X - Y1] = 290.91 SQ.MT.X1	

STAIRCASE & LIFT AREA CAL. FOR BLDG.NO.2-TYPICAL FLOOR PLAN(24th-29th & 29th)(WING-B2)	
STAR.2	4.81 X 4.39 X 1NO = 21.12 SQ.MT.
ST.1	0.15 X 1.11 X 1NO = 0.17 SQ.MT.
ST.2	(4.81 + 3.47) / 2 X 1.26 = 5.22 SQ.MT.
ST.LO.1	2.08 X 2.46 X 1NO = 5.12 SQ.MT.
ST.LO.2	0.715 X 2.00 X 1NO = 1.43 SQ.MT.
ST.LO.3	0.15 X 1.55 X 1NO = 0.23 SQ.MT.
LIFT.2	2.73 X 2.46 X 1NO = 6.72 SQ.MT.
LOBBY	5.46 X 2.00 X 1NO = 10.92 SQ.MT.
LIFT.3	2.00 X 2.46 X 1NO = 4.92 SQ.MT.
LIFT.4	2.00 X 2.15 X 1NO = 4.30 SQ.MT.
LO.1	0.15 X 0.75 X 1NO = 0.11 SQ.MT.
LIFT.4	2.61 X 2.71 X 1NO = 7.07 SQ.MT.
LT	(2.31 + 2.61) / 2 X 0.50 = 1.16 SQ.MT.
LOBBY	3.04 X 2.36 X 1NO = 7.17 SQ.MT.
LO.1	(3.39 + 3.69) / 2 X 0.29 = 1.03 SQ.MT.
LO.2	(1.85 + 2.49) / 2 X 0.64 = 1.39 SQ.MT.
LO.3	0.64 X 2.00 X 1NO = 1.28 SQ.MT.
LO.4	0.55 X 1.10 X 0.5NO = 0.30 SQ.MT.
LO.5	(0.63 + 1.16) / 2 X 0.53 = 0.47 SQ.MT.
LO.6	(0.78 + 0.63) / 2 X 0.15 = 0.10 SQ.MT.
LO.7	0.52 X 0.26 X 0.5NO = 0.07 SQ.MT.
TOTAL STAIR. & LIFT AREA PER FL. = 80.32 SQ.MT.	
NET B.U.AREA OF TYP. FLR. OF SALE RESIDENCE (290.91-80.32) = 210.59 SQ.MT.	

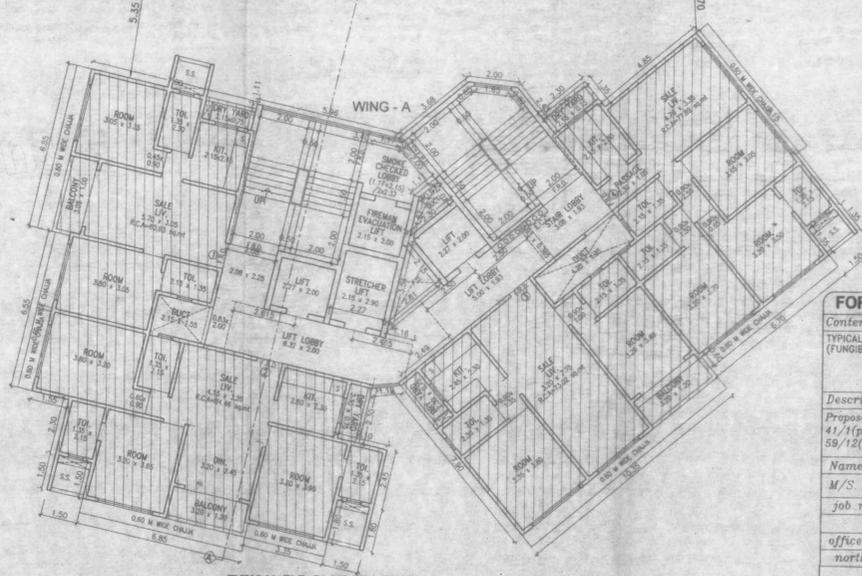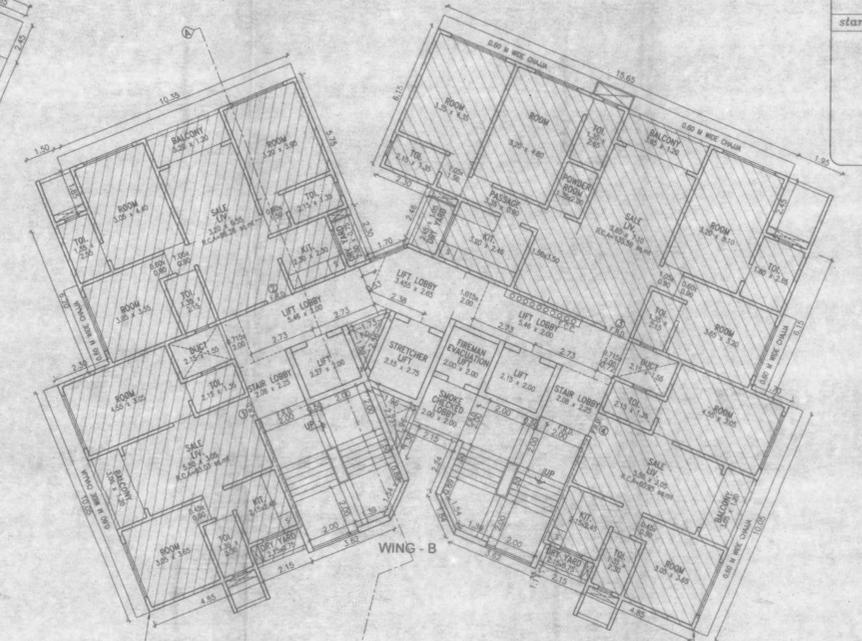

TYPICAL FLR. PLAN (24th-29th) OF WING "A & B" FOR BLDG. NO.2(SALE) (FUNGIBLE FSI)
 SCALE 1:100

Contents of sheet
 TYPICAL FLR. PLAN (24th-29th) OF WING "A & B" FOR SALE BUILDING NO.2 (FUNGIBLE FSI)


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 Proposed slum rehabilitation scheme on plot bearing c.t.s. no.41(pt.), 41/1(pt.), 41/2(pt.), 41/3(pt.), 41/4(pt.), 59/1 to 11 and 59/12(pt.) of village Bandivali of Jogeshwari (west), Mumbai-400102

Name of owner M/S. CHANDIVALA ENTERPRISES PVT.LTD. Owner signature
 job no. date drg. no. scale checked by drawn by AS SHOWN NILOFAR


office ref. no. north architect signature

m/s.t.n.hasan
 B-14, 1st Fl., Bhandra Chs, 51-51/1st Road, Bhandra (W), Mumbai. Tel:26418052


Approved Subject to the condition
Mentioned in this plan permission
Letter No. K-44/P/11/18/12/2002/4/15
Dated 8 SEP 2005
KVP/11/18/12/2002/4/15
Slum Rehabilitation Authority
Biharimurad

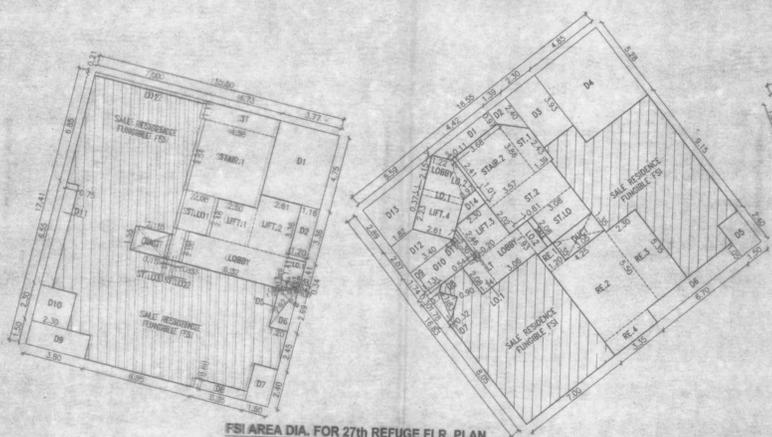


FSI AREA DIA. FOR 27th REFUGE FLR. PLAN OF WING "A" FOR BLDG. NO.2(SALE)

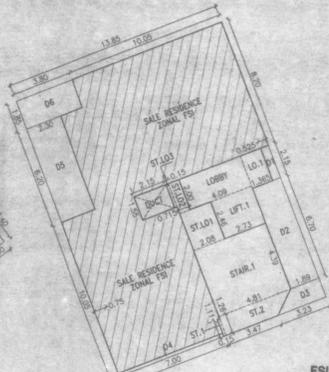

FSI AREA DIA. FOR 27th REFUGE FLR. PLAN OF WING "B" FOR BLDG. NO.2(SALE)

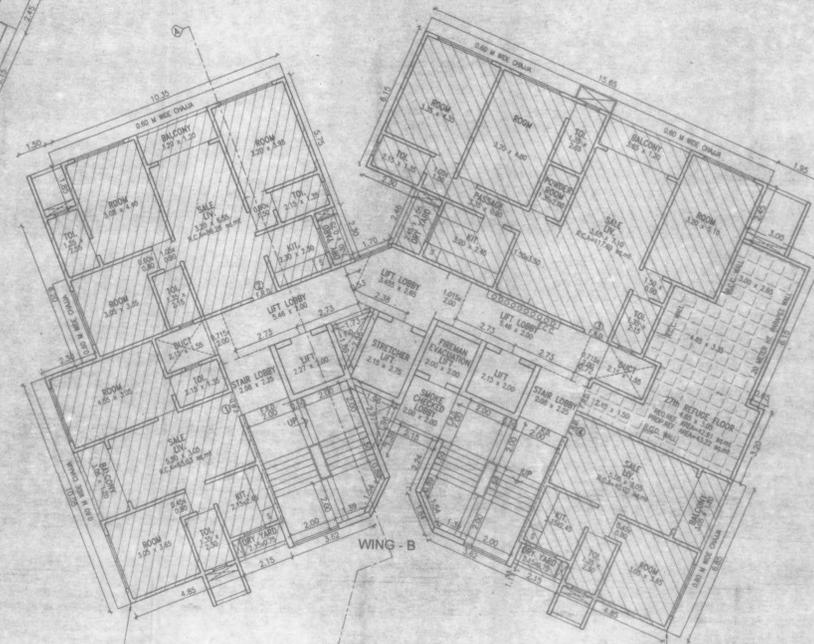

WING - B

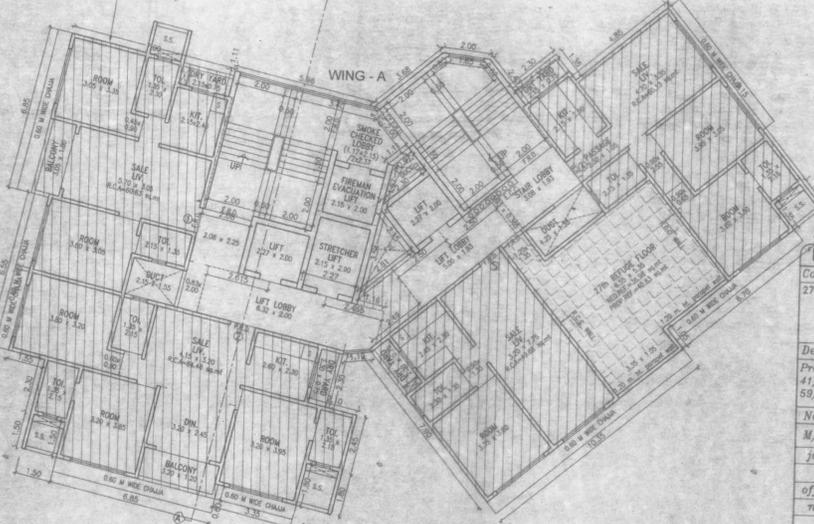

WING - A

27th REFUGE FLR. PLAN OF WING "A & B" FOR BLDG. NO.2(SALE) (FUNGIBLE FSI) SCALE 1:100

BUILT UP AREA CALCULATION FOR BLDG.NO.2 27th REFUGE FLOOR PLAN (WING-A1)

1	18.50 X 17.41 X 1NO	= 289.86 SQ.MT.
TOTAL ADDITION = 289.86 SQ.MT. X		
DEDUCTIONS :-		
D1	3.77 X 4.75 X 1 X 1NO	= 17.91 SQ.MT.
D2	1.86 X 3.35 X 1 X 1NO	= 6.23 SQ.MT.
D3	0.53 X 0.20 X 0.5 X 1NO	= 0.05 SQ.MT.
D4	0.53 X 0.11 X 0.5 X 1NO	= 0.03 SQ.MT.
D5	2.82 X 0.88 X 0.5 X 1NO	= 1.30 SQ.MT.
D6	(0.07 + 1.20) / 2 X 2.89	= 1.71 SQ.MT.
D7	1.50 X 2.40 X 1 X 1NO	= 3.60 SQ.MT.
D8	3.35 X 0.60 X 1 X 1NO	= 2.01 SQ.MT.
D9	3.80 X 1.50 X 1 X 1NO	= 5.70 SQ.MT.
D10	2.30 X 2.30 X 1 X 1NO	= 5.29 SQ.MT.
D11	0.75 X 0.55 X 1 X 1NO	= 0.41 SQ.MT.
D12	7.00 X 0.21 X 1 X 1NO	= 1.47 SQ.MT.
D13	2.15 X 1.55 X 1 X 1NO	= 3.33 SQ.MT.
DUCT 2.15 X 1.55 X 1 X 1NO = 3.33 SQ.MT.		
TOTAL DEDUCTION = 51.21 SQ.MT.X		
TOTAL BUILT UP AREA (X - Y1) = 218.65 SQ.MT.X		

BUILT UP AREA CALCULATION FOR BLDG.NO.2 27th REFUGE FLOOR PLAN (WING-A2)

1	18.55 X 16.83 X 1NO	= 312.20 SQ.MT.
TOTAL ADDITION = 312.20 SQ.MT. X		
DEDUCTIONS :-		
D1	(4.42 + 3.68) / 2 X 0.97	= 3.93 SQ.MT.
D2	(0.97 + 2.40) / 2 X 1.39	= 2.34 SQ.MT.
D3	2.30 X 3.53 X 1 X 1NO	= 8.04 SQ.MT.
D4	4.85 X 5.28 X 1 X 1NO	= 25.61 SQ.MT.
D5	1.50 X 2.40 X 1 X 1NO	= 3.60 SQ.MT.
D6	6.70 X 1.05 X 1 X 1NO	= 7.04 SQ.MT.
D7	(0.74 + 0.32) / 2 X 1.78	= 0.82 SQ.MT.
D8	1.83 X 0.90 X 0.5 X 1NO	= 0.82 SQ.MT.
D9	(1.13 + 0.74) / 2 X 0.30	= 0.28 SQ.MT.
D10	3.40 X 1.74 X 1 X 1NO	= 5.92 SQ.MT.
D11	(1.74 + 3.50) / 2 X 0.54	= 1.09 SQ.MT.
D12	(1.82 + 3.40) / 2 X 2.07	= 5.40 SQ.MT.
D13	(1.82 + 5.59) / 2 X 2.89	= 10.71 SQ.MT.
D14	(0.97 + 2.30) / 2 X 1.01	= 1.65 SQ.MT.
DUCT 3.05 X 1.35 X 1 X 1NO = 4.12 SQ.MT.		
TOTAL DEDUCTION = 62.49 SQ.MT.X		
TOTAL BUILT UP AREA (X - Y1) = 224.71 SQ.MT.X		

BUILT UP AREA CALCULATION FOR BLDG.NO.2 27th REFUGE FLOOR PLAN (WING-B1)

1	19.30 X 18.88 X 1NO	= 364.00 SQ.MT.
TOTAL ADDITION = 364.00 SQ.MT. X		
DEDUCTIONS :-		
D1	0.525 X 2.15 X 1 X 1NO	= 1.13 SQ.MT.
D2	1.89 X 6.70 X 1 X 1NO	= 12.66 SQ.MT.
D3	(1.89 + 3.25) / 2 X 1.26	= 3.22 SQ.MT.
D4	7.00 X 0.21 X 1 X 1NO	= 1.47 SQ.MT.
D5	2.30 X 4.20 X 1 X 1NO	= 9.66 SQ.MT.
D6	3.80 X 1.85 X 1 X 1NO	= 7.02 SQ.MT.
D7	2.15 X 1.55 X 1 X 1NO	= 3.33 SQ.MT.
DUCT 2.15 X 1.55 X 1 X 1NO = 3.33 SQ.MT.		
TOTAL DEDUCTION = 43.10 SQ.MT.X		
TOTAL BUILT UP AREA (X - Y1) = 210.48 SQ.MT.X		

BUILT UP AREA CALCULATION FOR BLDG.NO.2 27th REFUGE FLOOR PLAN (WING-B2)

1	19.30 X 18.88 X 1NO	= 364.00 SQ.MT.
TOTAL ADDITION = 364.00 SQ.MT. X		
DEDUCTIONS :-		
D1	3.65 X 2.45 X 1 X 1NO	= 8.94 SQ.MT.
D2	0.65 X 6.15 X 1 X 1NO	= 4.00 SQ.MT.
D3	7.00 X 0.21 X 1 X 1NO	= 1.47 SQ.MT.
D4	(2.15 + 3.49) / 2 X 1.26	= 3.55 SQ.MT.
D5	2.15 X 2.24 X 1 X 1NO	= 4.82 SQ.MT.
D6	1.96 X 4.25 X 1 X 1NO	= 8.33 SQ.MT.
D7	(4.78 + 4.25) / 2 X 0.50	= 2.25 SQ.MT.
D8	0.11 X 7.31 X 1 X 1NO	= 0.80 SQ.MT.
D9	(7.05 + 8.57) / 2 X 0.26	= 1.87 SQ.MT.
D10	0.84 X 8.57 X 1 X 1NO	= 7.20 SQ.MT.
D11	(0.84 + 0.15) / 2 X 0.48	= 0.46 SQ.MT.
D12	0.55 X 0.15 X 0.5 X 1NO	= 0.04 SQ.MT.
D13	(1.10 + 2.30) / 2 X 1.20	= 2.04 SQ.MT.
D14	2.30 X 2.46 X 1 X 1NO	= 5.66 SQ.MT.
DUCT 2.15 X 1.55 X 1 X 1NO = 3.33 SQ.MT.		
TOTAL DEDUCTION = 66.83 SQ.MT.X		
TOTAL BUILT UP AREA (X - Y1) = 297.37 SQ.MT.X		


STAIRCASE & LIFT AREA CAL. FOR BLDG.NO.2- 27th REFUGE FLOOR (WING-B1)

STAR1	4.81 X 4.30 X 1NO	= 21.12 SQ.MT.
STAR2	4.81 X 4.30 X 1NO	= 21.12 SQ.MT.
STAR3	4.81 X 4.30 X 1NO	= 21.12 SQ.MT.
STAR4	4.81 X 4.30 X 1NO	= 21.12 SQ.MT.
STAR5	4.81 X 4.30 X 1NO	= 21.12 SQ.MT.
STAR6	4.81 X 4.30 X 1NO	= 21.12 SQ.MT.
STAR7	4.81 X 4.30 X 1NO	= 21.12 SQ.MT.
STAR8	4.81 X 4.30 X 1NO	= 21.12 SQ.MT.
STAR9	4.81 X 4.30 X 1NO	= 21.12 SQ.MT.
STAR10	4.81 X 4.30 X 1NO	= 21.12 SQ.MT.
STAR11	4.81 X 4.30 X 1NO	= 21.12 SQ.MT.
STAR12	4.81 X 4.30 X 1NO	= 21.12 SQ.MT.
STAR13	4.81 X 4.30 X 1NO	= 21.12 SQ.MT.
STAR14	4.81 X 4.30 X 1NO	= 21.12 SQ.MT.
STAR15	4.81 X 4.30 X 1NO	= 21.12 SQ.MT.
STAR16	4.81 X 4.30 X 1NO	= 21.12 SQ.MT.
STAR17	4.81 X 4.30 X 1NO	= 21.12 SQ.MT.
STAR18	4.81 X 4.30 X 1NO	= 21.12 SQ.MT.
STAR19	4.81 X 4.30 X 1NO	= 21.12 SQ.MT.
STAR20	4.81 X 4.30 X 1NO	= 21.12 SQ.MT.
STAR21	4.81 X 4.30 X 1NO	= 21.12 SQ.MT.
STAR22	4.81 X 4.30 X 1NO	= 21.12 SQ.MT.
STAR23	4.81 X 4.30 X 1NO	= 21.12 SQ.MT.
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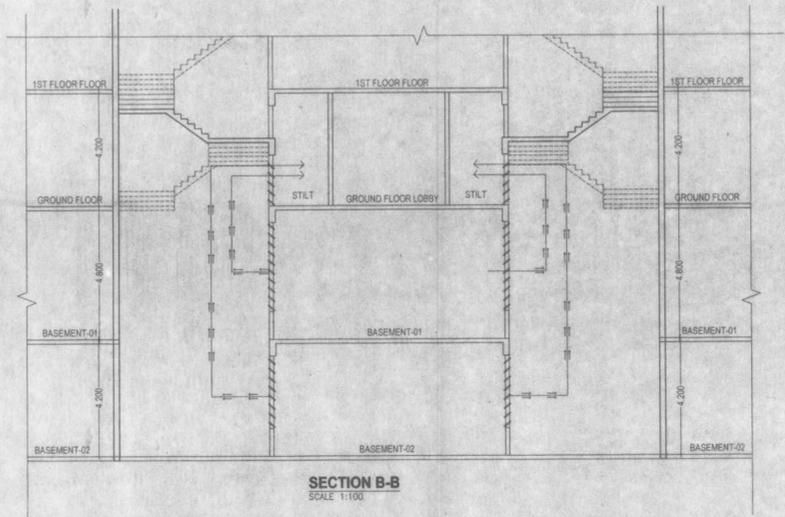
stamp of approval of plan

Approved Subject to the condition
Mentioned in the office permission
Letter No. KID/PT/166/2022/023/AP/5
Date: 02/08/2024
02/08/2024


Approved Subject to the condition
Mentioned in the office permission
Letter No. KID/PT/166/2022/023/AP/5
Date: 02/08/2024
Executive Engineer
Slum Rehabilitation Authority
Brihanmumbai

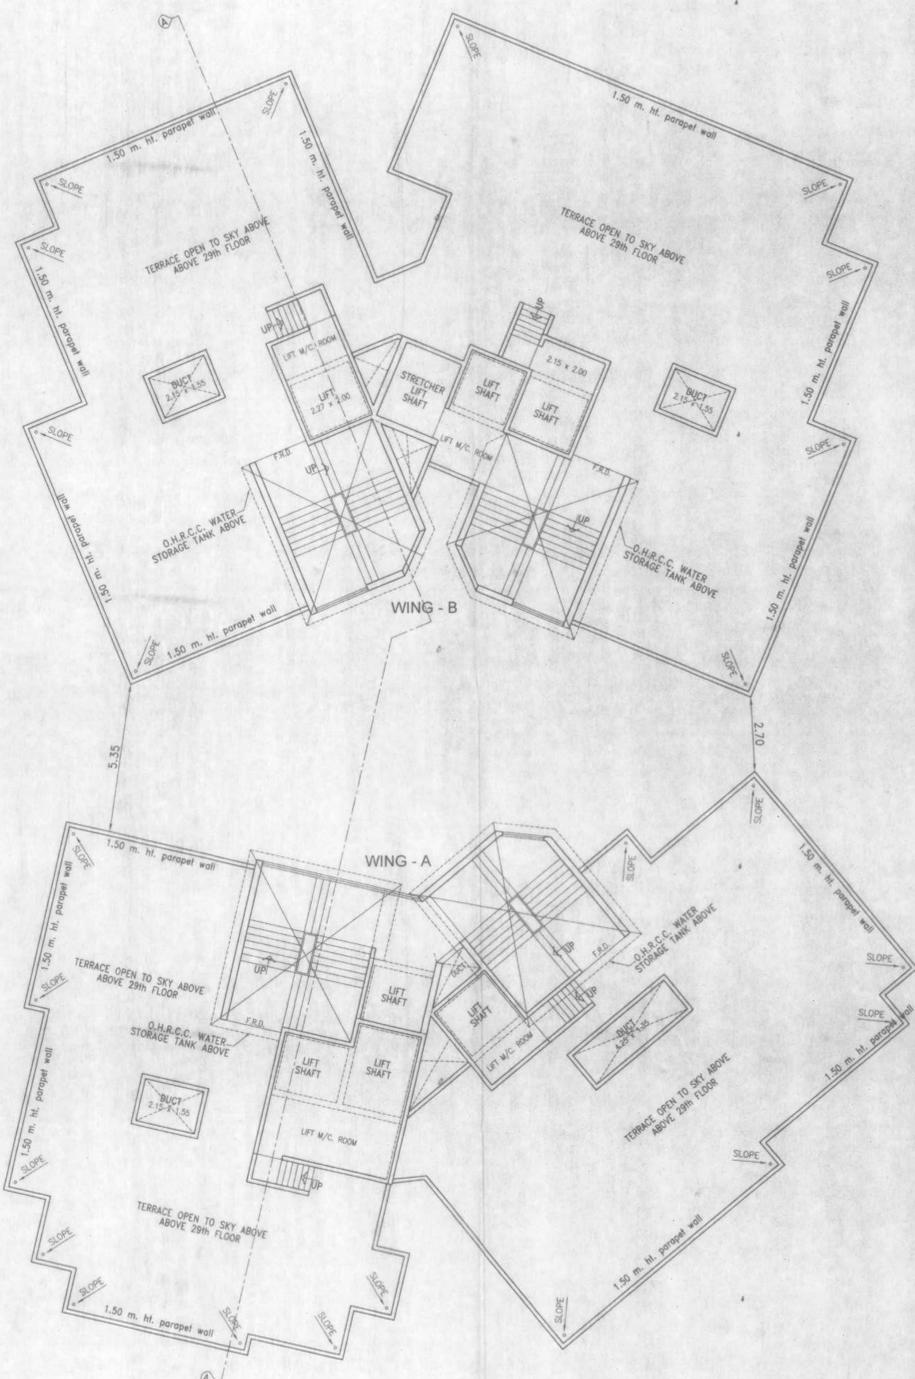

TERRACE FLR. PLAN OF WING "A & B" FOR BLDG. NO.2(SALE)
SCALE 1:100



SECTION B-B
SCALE 1:100

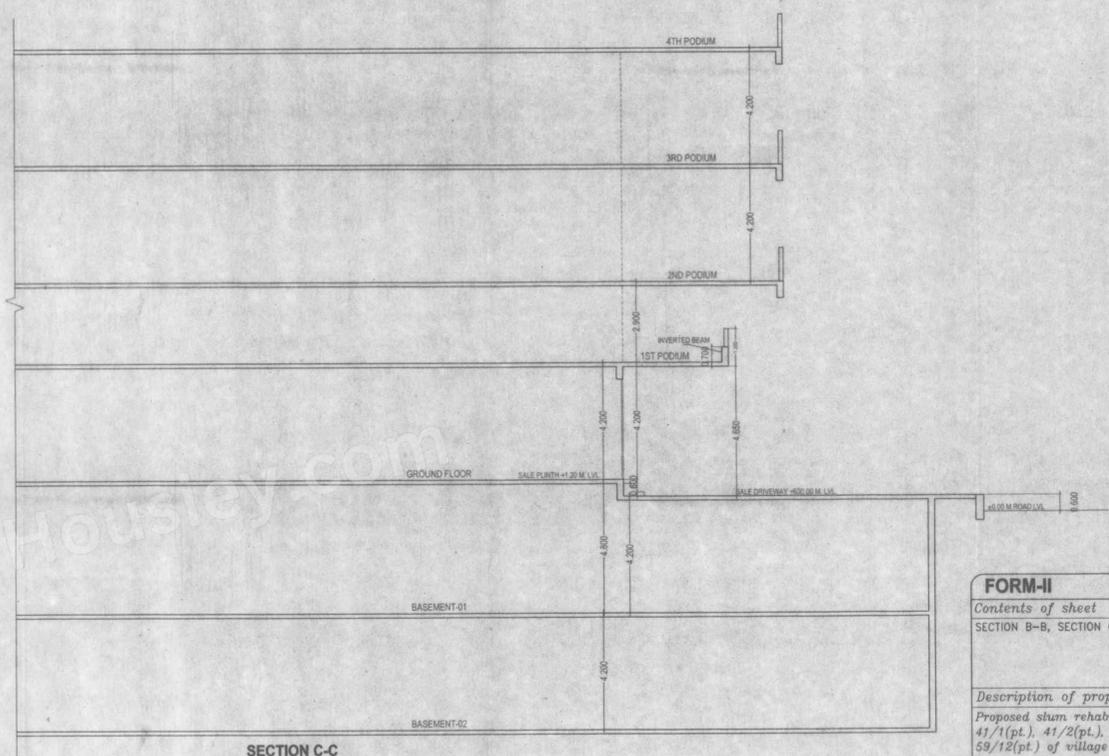

SECTION C-C
SCALE 1:100

Contents of sheet
SECTION B-B, SECTION C-C & TERRACE FLOOR PLAN FOR SALE BUILDING NO.2

Description of proposal and property
Proposed slum rehabilitation scheme on plot bearing c.t.s. no.41(pt.), 41/1(pt.), 41/2(pt.), 41/3(pt.), 41/4(pt.), 59(pt.), 59/1 to 11 and 59/12(pt.) of village Bandivali at Jogeshwari (west), Mumbai-400102

Name of owner M/S. CHANDIVALA ENTERPRISES PVT.LTD. Owner signature

job no. date drg. no. scale checked by drawn by
AS SHOWN NILOFAR

office ref. no.: north architect signature

m/s.t.n.hasan
B-14, 1st Flr., Bhoja CHS, 51-Hill Road, Bandra (W), Mumbai. Tel.26418052

