
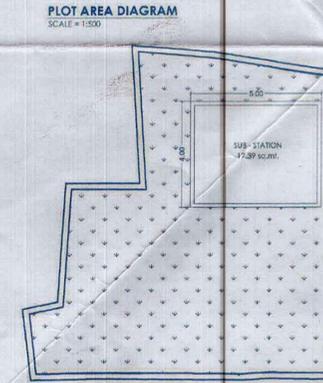


REHAB COMMERCIAL CARPET AREA STATEMENT					
SHOP NO	AS PER ANNEX III	AS PER ANNEX II	PERMISSIBLE AREA	PROPOSED AREA	COUNTED IN
1	49	6.50	6.50	6.70	0.20
2	86	6.50	6.50	6.53	0.03
3	107	7.43	7.43	7.48	0.05
4	101	3.25	3.25	3.77	0.52
5	68	10.03	10.03	10.11	0.08
6	87	8.92	8.92	9.06	0.14
7	85	6.50	6.50	6.69	0.19
8	30	4.92	4.92	5.75	0.83
9	126	2.51	2.51	2.86	0.35
10	131	3.19	3.19	3.51	0.32
11	1	9.66	9.66	9.95	0.29
12	49	11.70	11.70	12.07	0.37
13	119	5.20	5.20	5.20	0.00
15	94	4.64	4.64	5.05	0.41
16	20	20.90	20.90	20.95	0.05
17	88	7.80	7.80	8.24	0.44
18	100	8.17	8.17	8.62	0.45
19	139	15.32	15.32	15.34	0.02
20	56	6.50	6.50	6.87	0.37
21	138	14.35	14.35	14.77	0.42
22	18	13.29	13.29	13.43	0.14
23	84	5.57	5.57	6.31	0.74
24	12	20.90	20.90	20.90	0.00
25	124	5.02	5.02	5.04	0.02
26	80	10.22	10.22	10.22	0.00
27	74	13.00	13.00	13.10	0.10
28	9	7.43	7.43	7.60	0.17
<b>TOTAL</b>	<b>239.42</b>	<b>239.42</b>	<b>246.12</b>	<b>6.70</b>	



6.70 X 1.20 = 8.04 SQ.MT

**PLOT AREA CALCULATION BY TRANGULATION METHOD**

1.	7.36 X 1.87 X 0.50	=	6.88 SQ.M
2.	25.77 X 6.11 X 0.50	=	87.89 SQ.M
3.	28.42 X 11.08 X 0.50	=	161.45 SQ.M
4.	32.99 X 9.02 X 0.50	=	148.78 SQ.M
5.	34.57 X 8.83 X 0.50	=	157.80 SQ.M
6.	34.94 X 3.70 X 0.50	=	64.64 SQ.M
7.	4.78 X 1.98 X 0.50	=	4.73 SQ.M
8.	4.33 X 2.15 X 0.50	=	4.65 SQ.M
9.	4.33 X 2.19 X 0.50	=	4.74 SQ.M
10.	5.76 X 2.54 X 0.50	=	7.32 SQ.M
11.	36.11 X 3.15 X 0.50	=	56.87 SQ.M
12.	36.34 X 2.90 X 0.50	=	52.69 SQ.M
13.	37.77 X 8.61 X 0.50	=	162.95 SQ.M
14.	36.67 X 8.15 X 0.50	=	149.42 SQ.M
15.	37.77 X 8.32 X 0.50	=	156.47 SQ.M
16.	41.88 X 4.06 X 0.50	=	84.24 SQ.M
17.	38.49 X 4.01 X 0.50	=	77.17 SQ.M
18.	5.32 X 2.68 X 0.50	=	7.13 SQ.M
19.	8.03 X 5.77 X 0.50	=	23.29 SQ.M
20.	20.25 X 7.98 X 0.50	=	79.78 SQ.M
21.	35.80 X 4.53 X 0.50	=	80.67 SQ.M
22.	38.49 X 12.97 X 0.50	=	249.40 SQ.M
23.	14.71 X 10.65 X 0.50	=	78.33 SQ.M
24.	9.46 X 4.29 X 0.50	=	20.29 SQ.M
25.	3.26 X 2.48 X 0.50	=	4.04 SQ.M
26.	12.06 X 3.34 X 0.50	=	20.14 SQ.M
27.	3.26 X 1.49 X 0.50	=	2.43 SQ.M
28.	2.98 X 1.30 X 0.50	=	1.94 SQ.M
29.	16.45 X 2.77 X 0.50	=	22.79 SQ.M
30.	14.15 X 1.73 X 0.50	=	12.24 SQ.M
31.	18.14 X 4.16 X 0.50	=	37.73 SQ.M
<b>TOTAL AREA</b>		=	<b>1929.08 SQ.MT</b>

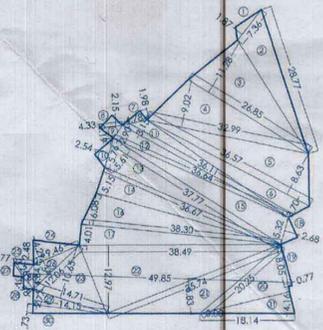

**GROUND FLOOR PLAN SCALE 1:100**

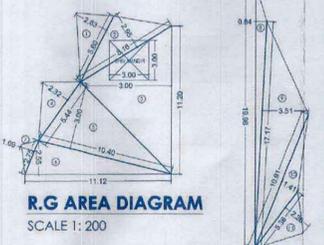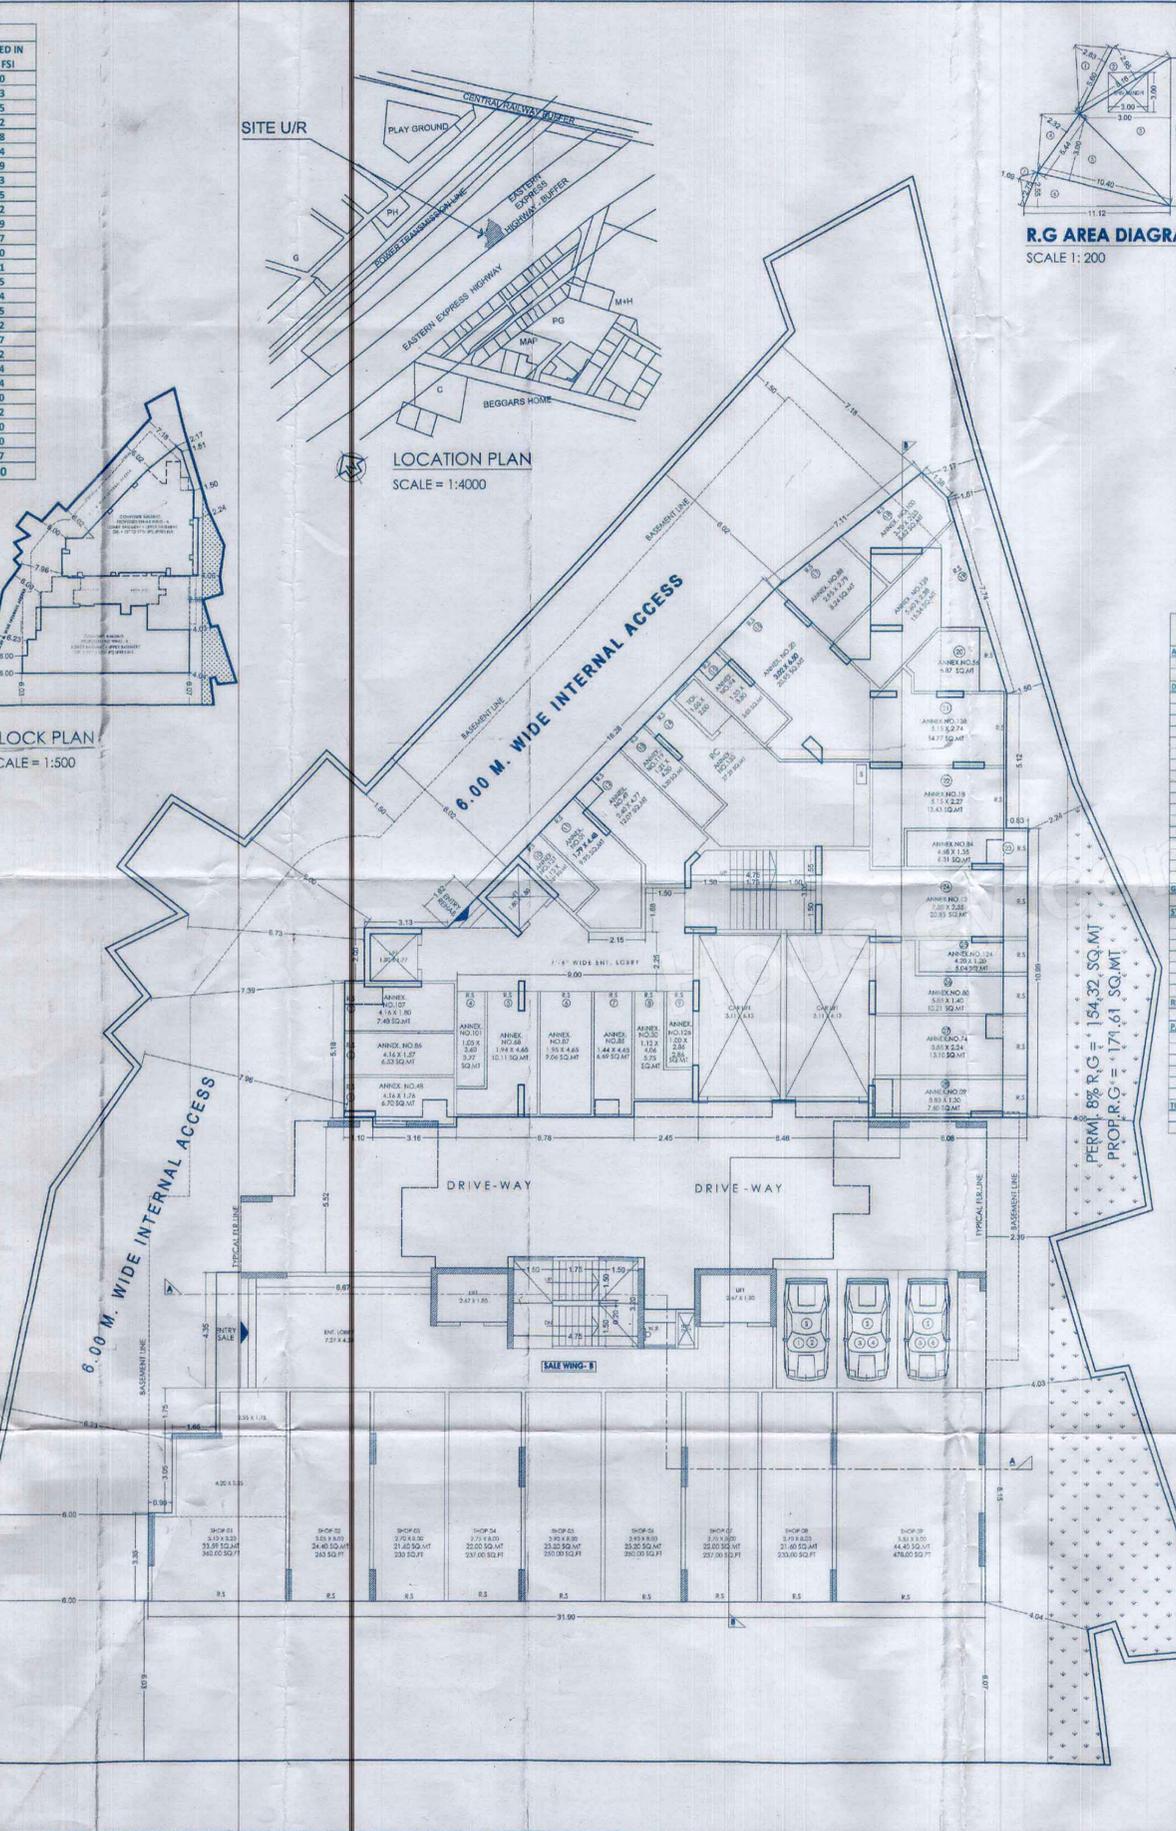

R.G AREA CALCULATION								
1	5.60	x	2.63	x	0.5	=	7.36	Sq.mtr.
2	8.16	x	2.95	x	0.5	=	12.04	Sq.mtr.
3	11.20	x	3.00	x	0.5	=	16.80	Sq.mtr.
4	5.44	x	2.32	x	0.5	=	6.31	Sq.mtr.
5	10.40	x	3.00	x	0.5	=	15.60	Sq.mtr.
6	11.12	x	2.55	x	0.5	=	14.18	Sq.mtr.
7	2.75	x	1.09	x	0.5	=	1.50	Sq.mtr.
8	19.96	x	1.94	x	0.5	=	19.38	Sq.mtr.
9	17.17	x	2.50	x	0.5	=	21.46	Sq.mtr.
10	10.91	x	1.41	x	0.5	=	7.69	Sq.mtr.
11	5.36	x	2.26	x	0.5	=	6.06	Sq.mtr.
12	14.99	x	1.07	x	0.5	=	8.02	Sq.mtr.
13	11.35	x	1.25	x	0.5	=	7.09	Sq.mtr.
14	11.35	x	3.02	x	0.5	=	17.14	Sq.mtr.
15	3.95	x	1.16	x	0.5	=	2.29	Sq.mtr.
16	14.99	x	1.07	x	0.5	=	8.02	Sq.mtr.
17	19.96	x	1.52	x	0.5	=	15.17	Sq.mtr.
18	5.26	x	2.09	x	0.5	=	5.50	Sq.mtr.
<b>TOTAL</b>						=	<b>180.61</b>	<b>Sq.mtr.</b>
<b>A</b>	<b>3.00</b>	<b>x</b>	<b>3</b>	<b>x</b>	<b>1</b>	=	<b>9.00</b>	<b>Sq.mtr.</b>


TOTAL R.G. AREA = 180.61 - 9.00 = 171.61 SQ.MT  
 NET PLOT AREA = 1929.08 SQ.MT  
 PERMISSIBLE 8% R.G = 154.32 SQ.MT  
 PROPOSED R.G = 171.61 SQ.MT

PERM. 8% R.G = 154.32 SQ.MT  
 PROP. R.G = 171.61 SQ.MT



BUILT UP AREA CALCULATION GROUND FLOOR PLAN (REHAB WING - A)								
<b>ADDITIONS:</b>								
A	26.03	x	24.84	x	1	=	646.59	Sq.mtr.
<b>TOTAL</b>						=	<b>646.59</b>	<b>Sq.mtr.</b>
<b>REDUCTIONS:</b>								
1	0.75	x	2.00	x	1	=	1.50	Sq.mtr.
2	3.89	x	17.33	x	1	=	67.34	Sq.mtr.
3	18.00	x	12.01	x	0.5	=	108.18	Sq.mtr.
4	18	x	4.99	x	0.5	=	39.24	Sq.mtr.
5	4.55	x	0.97	x	0.5	=	1.99	Sq.mtr.
6	8.38	x	3.01	x	0.5	=	12.78	Sq.mtr.
7	8.33	x	0.83	x	0.5	=	3.46	Sq.mtr.
8	0.83	x	5.15	x	1	=	4.26	Sq.mtr.
9	0.58	x	0.38	x	1	=	2.21	Sq.mtr.
10	0.45	x	6.26	x	1	=	41.09	Sq.mtr.
11	0.91	x	0.97	x	1	=	0.88	Sq.mtr.
12	0.78	x	0.38	x	1	=	2.58	Sq.mtr.
13	1.50	x	0.38	x	1	=	0.92	Sq.mtr.
14	1.62	x	0.61	x	0.5	=	0.49	Sq.mtr.
15	1.98	x	1.06	x	0.5	=	2.07	Sq.mtr.
16	1.14	x	2.00	x	0.5	=	2.31	Sq.mtr.
<b>TOTAL</b>						=	<b>299.48</b>	<b>Sq.mtr.</b>
<b>REHAB BUILT UP AREA:</b>						=	<b>347.11</b>	<b>Sq.mtr.</b>
<b>STAIRS, STAIRCASE LOBBY, LIFT, LOBBY AREA:</b>								
S71	3.85	x	3.35	x	1	=	12.90	Sq.mtr.
S72	1.30	x	1.08	x	0.5	=	0.70	Sq.mtr.
S73	1.38	x	2.48	x	1	=	3.42	Sq.mtr.
S74	1.50	x	1.50	x	1	=	2.25	Sq.mtr.
L71	3.98	x	2.00	x	1	=	7.96	Sq.mtr.
L72	2.03	x	3.75	x	1	=	7.61	Sq.mtr.
<b>TOTAL</b>						=	<b>34.79</b>	<b>Sq.mtr.</b>
<b>REHAB COMPONENT AREA:</b>						=	<b>312.31</b>	<b>Sq.mtr.</b>
<b>PASSAGE AREA:</b>								
P1	4.56	x	0.80	x	1	=	3.65	Sq.mtr.
P2	1.42	x	1.45	x	0.5	=	1.03	Sq.mtr.
P3	3.65	x	2.25	x	1	=	8.21	Sq.mtr.
P4	0.32	x	2.20	x	1	=	0.70	Sq.mtr.
P5	1.50	x	0.35	x	1	=	0.52	Sq.mtr.
<b>TOTAL</b>						=	<b>13.86</b>	<b>Sq.mtr.</b>
<b>NET REHAB BUILT UP AREA:</b>						=	<b>298.45</b>	<b>Sq.mtr.</b>

BUILT UP AREA CALCULATION GROUND FLOOR PLAN (SALE WING - A)								
<b>ADDITIONS:</b>								
A	31.00	x	13.1	x	1	=	417.89	Sq.mtr.
<b>TOTAL</b>						=	<b>417.89</b>	<b>Sq.mtr.</b>
<b>REDUCTIONS:</b>								
1	0.90	x	3.05	x	1	=	2.75	Sq.mtr.
2	2.55	x	1.75	x	1	=	4.46	Sq.mtr.
3	3.81	x	4.95	x	1	=	18.98	Sq.mtr.
4	7.32	x	4.35	x	1	=	31.64	Sq.mtr.
5	7.82	x	0.8	x	1	=	6.26	Sq.mtr.
6	2.90	x	0.42	x	1	=	1.22	Sq.mtr.
7	1.91	x	2.10	x	1	=	4.01	Sq.mtr.
8	3.33	x	0.42	x	1	=	1.41	Sq.mtr.
9	8.00	x	4.95	x	1	=	39.60	Sq.mtr.
<b>TOTAL</b>						=	<b>106.96</b>	<b>Sq.mtr.</b>
<b>REHAB BUILT UP AREA:</b>						=	<b>311.93</b>	<b>Sq.mtr.</b>
<b>STAIRS, STAIRCASE LOBBY, LIFT, LOBBY AREA:</b>								
S71	4.08	x	3.45	x	1	=	14.08	Sq.mtr.
S72	1.50	x	1.50	x	1	=	2.25	Sq.mtr.
L71	3.13	x	3.98	x	1	=	12.46	Sq.mtr.
L72	3.13	x	4.93	x	1	=	15.44	Sq.mtr.
P1	3.13	x	0.55	x	1	=	1.72	Sq.mtr.
P2	5.39	x	1.10	x	1	=	8.09	Sq.mtr.
P3	3.13	x	1.35	x	1	=	4.23	Sq.mtr.
<b>TOTAL</b>						=	<b>57.70</b>	<b>Sq.mtr.</b>
<b>NET BUA:</b>						=	<b>254.23</b>	<b>Sq.mtr.</b>

**AREA DIAGRAM GROUND FLOOR PLAN (REHAB WING - A) SCALE: 1:100**

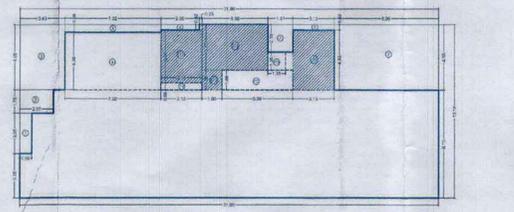

**AREA DIAGRAM GROUND FLOOR PLAN (SALE WING - B) SCALE: 1:100**

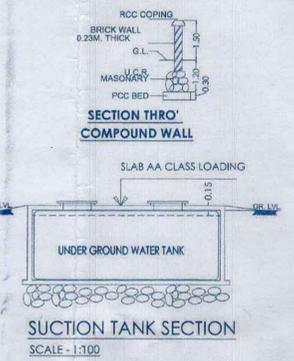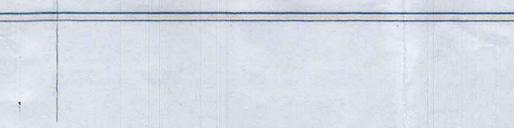

FORM - I SHEET NO - 1 / 8

**REHAB COMMERCIAL CARPET AREA STATEMENT**

NO	DESCRIPTION	AREA IN SQ.MT
1	AREA OF PLOT	1929.08
2	AREA OF RESERVATION IN PLOT	1929.08
3	AREA OF ROAD IN PLOT	1929.08
4	AREA OF OPEN SPACE	1929.08
5	AREA OF PAVEMENT	1929.08
6	AREA OF PLANTATION	1929.08
7	AREA OF FENCE	1929.08
8	AREA OF UTILITY	1929.08
9	AREA OF WATER TANK	1929.08
10	AREA OF STAIRS	1929.08
11	AREA OF LOBBY	1929.08
12	AREA OF LIFT	1929.08
13	AREA OF CORRIDOR	1929.08
14	AREA OF ENTRANCE	1929.08
15	AREA OF EXIT	1929.08
16	AREA OF PARKING	1929.08
17	AREA OF DRIVEWAY	1929.08
18	AREA OF PLAYGROUND	1929.08
19	AREA OF SPORTS	1929.08
20	AREA OF OTHER	1929.08
21	AREA OF TOTAL	1929.08

**REHAB COMMERCIAL CARPET AREA STATEMENT**

NO	DESCRIPTION	AREA IN SQ.MT
1	AREA OF PLOT	1929.08
2	AREA OF RESERVATION IN PLOT	1929.08
3	AREA OF ROAD IN PLOT	1929.08
4	AREA OF OPEN SPACE	1929.08
5	AREA OF PAVEMENT	1929.08
6	AREA OF PLANTATION	1929.08
7	AREA OF FENCE	1929.08
8	AREA OF UTILITY	1929.08
9	AREA OF WATER TANK	1929.08
10	AREA OF STAIRS	1929.08
11	AREA OF LOBBY	1929.08
12	AREA OF LIFT	1929.08
13	AREA OF CORRIDOR	1929.08
14	AREA OF ENTRANCE	1929.08
15	AREA OF EXIT	1929.08
16	AREA OF PARKING	1929.08
17	AREA OF DRIVEWAY	1929.08
18	AREA OF PLAYGROUND	1929.08
19	AREA OF SPORTS	1929.08
20	AREA OF OTHER	1929.08
21	AREA OF TOTAL	1929.08

**REHAB COMMERCIAL CARPET AREA STATEMENT**

NO	DESCRIPTION	AREA IN SQ.MT
1	AREA OF PLOT	1929.08
2	AREA OF RESERVATION IN PLOT	1929.08
3	AREA OF ROAD IN PLOT	1929.08